

CONTRA COSTA COUNTY DEPARTMENT OF CONSERVATION & DEVELOPMENT COMMUNITY DEVELOPMENT DIVISION

LAND USE PERMIT APPLICATION					
TO BE FILLED OUT BY APPLICANT OR OWNER					
OWNER Name New Cingular Wireless PCS, LLC (dba AT&T Mobility)	APPLICANT Name New Cingular Wireless PCS, LLC (dba AT&T Mobility)				
Address 4430 Rosewood Drive	Addres 6/0 Matt Yergovich, ExteNet Systems Real Estate Contracto				
City, State Pleasanton, CA 94588	City, State 1826 Webster St., San Francisco, CA 94115				
Phone	Phone (415) 596-3474				
By signing below, owner agrees to pay all costs, including any accrued interest, if the applicant does not pay costs. **M Check here if billings are to be sent to applicant rather than owner. **Owner's signature See Attached**	By signing below, applicant agrees to pay all costs for processing this application, plus any accrued interest, if the costs are not paid within 30 days of invoicing. Applicant's signature				
CONTACT PERSON (optional)	PROJECT DATA				
Name Matt Yergovich, ExteNet Real Estate Contractor for AT&T	Total Parcel Size: Public Right of Way				
Address 1826 Webster Street	Proposed Number of Units: 0				
City, State San Francisco, CA 94115	Proposed Square Footage: 0 (all equipment to be mounted on pole				
Phone (415) 596-3474	Estimated Project Value: \$10,000.00				
DESCRIPTION OF REQUEST (attach supplemental statement if n	ecessary): Request for conditional use permit associated with				
installation of AT&T distributed antenna system (DAS) node (#14) con	sisting of 2 panel antennas and associated equipment on wooden join				
utility pole in the public right of way on pole #110286196 near 801 Co	ventry Rd., Kensington. See attached project description				
OFFICE L					

Application Description: The applicant is requesting approval of a land use permit to attach a New Cingular Wireless distributed antenna system (DAS) node to an existing utility pole in the public right-of-way. The project consists of replacing the existing 39-foot tall pole with a new pole and attaching two panel antennas atop the pole for a total height of 50-feet 5-inches above-ground-level. The project also includes attaching the associated electrical equipment to the pole between 7-feet and 19-feet above-ground-level.

ROW TYPE OF FEE FEE S-CODE Ordinance Ref.: Assessor's No.: 571 - 080 - 012 Area: Kensington Site Address: 801 Coventry Rd. *Base Fee/Deposit Late Filing Penalty Fire District: Kensing fon Five Zoning District: R-6,-TOV-K S-066 (+50% of above if applicable) 1/2% est, value Sphere of Influence: El Gerrito Census Tract: 3910.00 S-029 over \$100,000 x \$195.00 #Units: Flood Zone: S-014 Sq. Ft. x \$0.20 \$15.00/ Panel Number: ' General Plan: Notification Fee S-052 \$30.00 Fish & Game Posting x-ref Files: (if not CEQA exempt) \$75.00 S-048 LP/DP Combination: YES / NO Env. Health Dept. \$57.00 5884 Supervisorial District: Other: Received by: Francisco Avila \$ 2,787.00 Concurrent Files: TOTAL Date Filed: March File Number: LP14-2014

will be charged if staff costs exceed base fee.

INSTRUCTIONS ON REVERSE SIDE

Receipt # |
*Additional fees based on time and materials

CONTRA COSTA COUNTY DEPARTMENT OF CONSERVATION AND DEVELOPMENT

COMMUNITY DEVELOPMENT DIVISION

30 Muir Road


Martinez, CA 94553-4601 Phone: 925-674-7205 Fax: 925-674-7258




Date

AGENCY COMMENT REQUEST


We request your comments regarding the attached app	lication currently under review.
DISTRIBUTION	Please submit your comments to:
<u>Internal</u>	Project Planner Francisco Avila
Building InspectionGrading Inspection	Phone # 925 - 674 - 7801
Advance PlanningHousing Programs	E-mail francisco Avila @dcd.cccounty.us
Trans. PlanningTelecom Planner	County File # <u>LP 14-2014</u>
ALUC StaffHCP/NCCP Staff	Prior to ASAP
APC Floodplain TechCounty Geologist	Prior to
Health Services Department	We have found the following special programs apply
Environmental HealthHazardous Materials	to this application:
Public Works Department	NO Active Fault Zone (Alquist-Priolo)
Engineering Services (Full-size)Traffic	X Flood Hazard Area, Panel #
Flood Control (Full-size)Special Districts	Yes 60-dBA Noise Control
Local	NO CA EPA Hazardous Waste Site
Fire District Kensington Fire	****
✓ Sanitary District Stege Sanitary	AGENCIES: Please indicate the applicable code
✓Water District £ B M ∪ D	section for any recommendation required by law or ordinance. Please send copies of your response to
City of El Cerrito	the Applicant and Owner.
School District(s)	
LAFCO	Comments:NoneBelowAttached
Reclamation District #	
East Bay Regional Park District	
Diablo/Discovery Bay/Crockett CSD	
MAC/TAC Kensington	
Improvement/Community Association	
Others/Non-local	
CHRIS - Sonoma State	
CA Fish and Wildlife, Region 3 – Bay Delta	
Additional Recipients	
	Drint Name
	Print Name
	Signature DATE
	Agency phone #

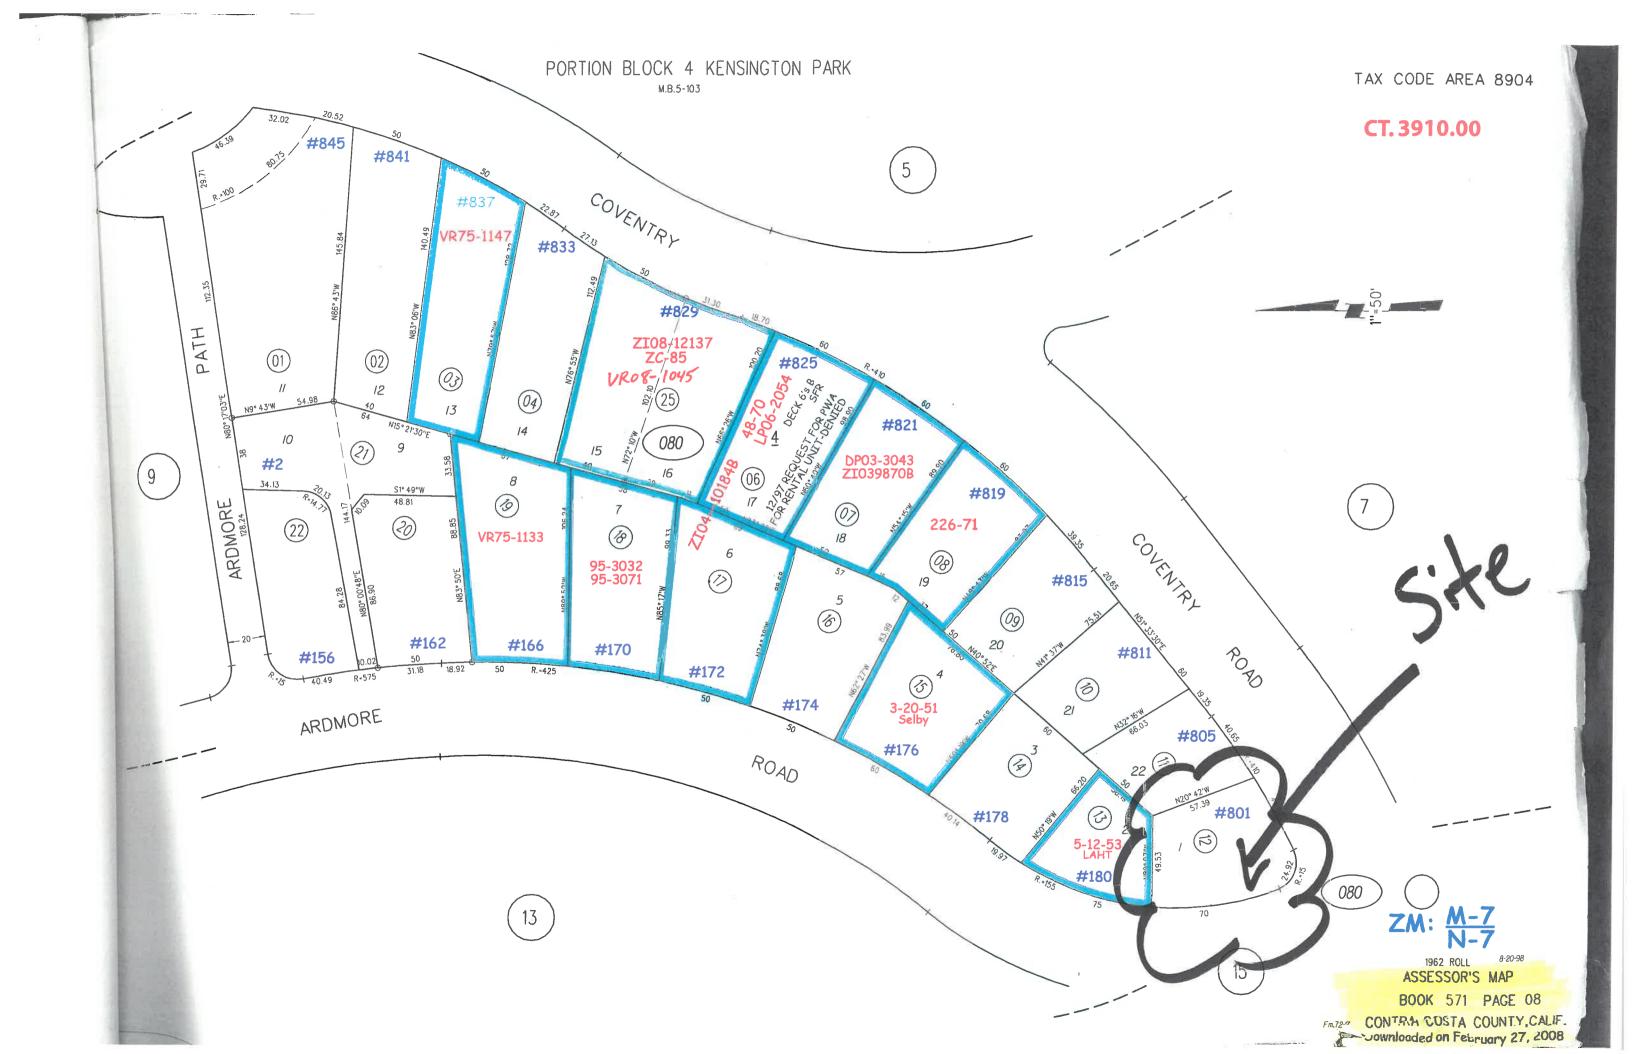


General Plan: Single-Fam. Res.-High Dens

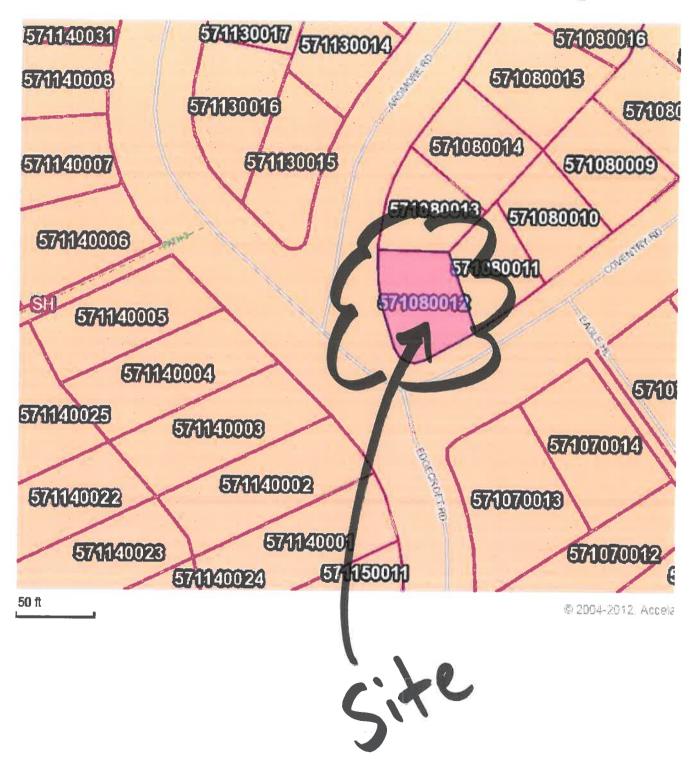


Zoning: R-6, -TOV -K

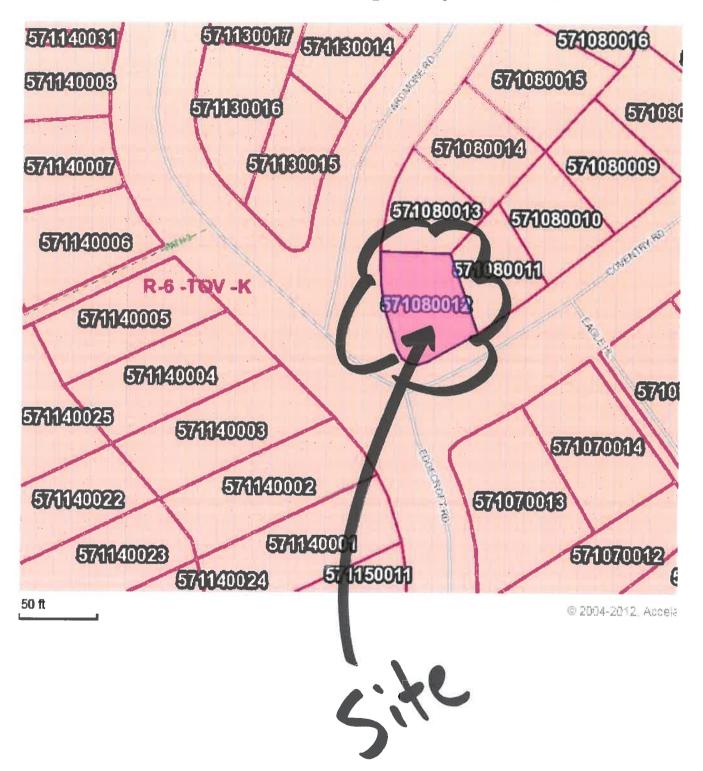

Kensington MAC

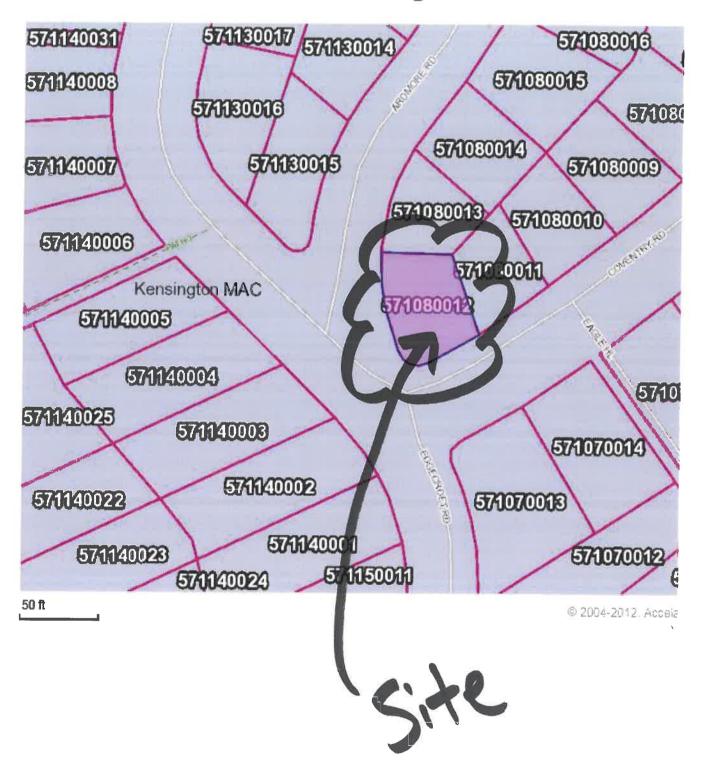

Aerial View

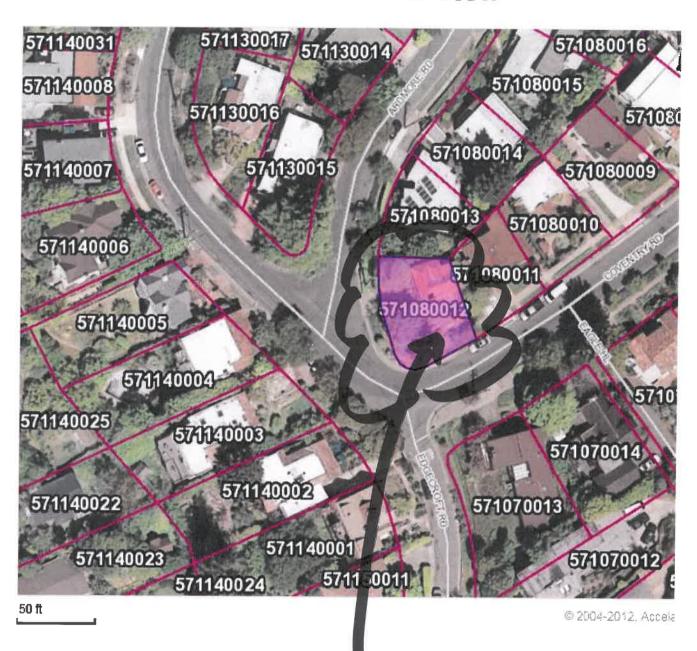

Page 1 of 2






AT&T Wireless

AdvanceSin

801 Coventry Road, Kensington, CA Oakhills AT&T North Network Node 014D

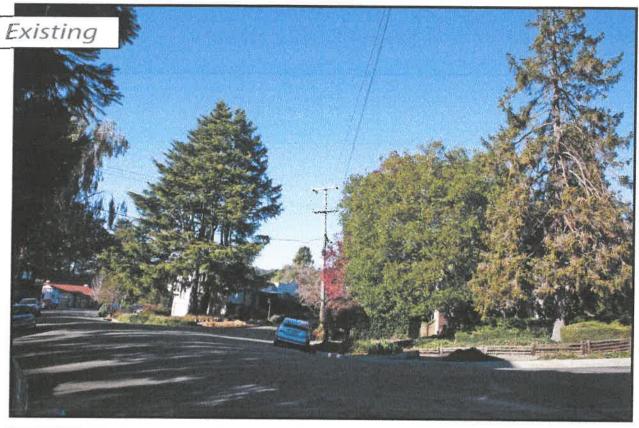




ATET Wireless

AdvanceSines Substitute Comment of Comments of Comment

801 Coventry Road, Kensington, CA Ookhills AT&T North Network Node 014D

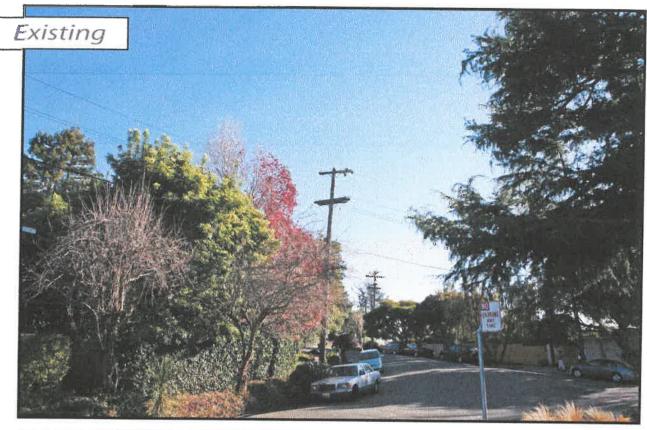




AT&T Wireless

801 Coventry Road, Kensington, CA Oakhills AT&T North Network Node 014D

AdvanceSime



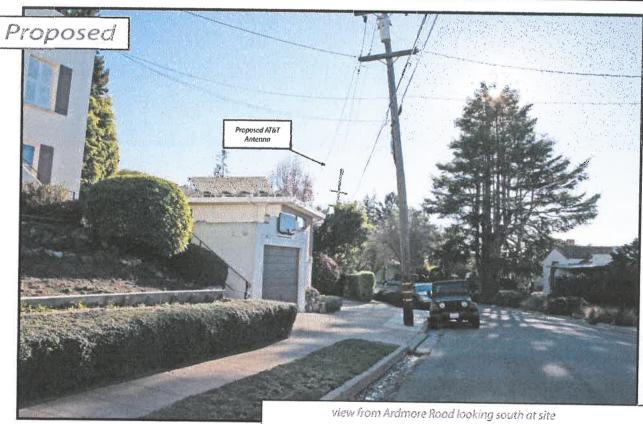

AdvanceSint

AT&T Wireless

801 Coventry Road, Kensington, CA Oakhills AT&T North Network Node 014D



PROPRIFTARY INFORMATION

THE INFORMATION CONTAINED IN THIS SET OF CONSTRUCTION DOCUMENTS IS PROPRIETARY BY NATURE. ANY USE OR DISCLOSURE OTHER THAN THAT WHICH RELATES TO CARRIER SERVICES IS STRICTLY PROHIBITED.

PHONE: (415) 596-3474

EMAIL: myergo@gmail.com

OAKHILLS AT&T NORTH NETWORK NODE 014D

ARDMORE RD NEXT TO 801 COVINGTON RD, KENSINGTON, CA 94707

NEW CINGULAR WIRELESS PCS, LLC 4430 ROSEWOOD DR, BLDG 3
PLEASANTON, CA 94588-3050

at&t

CURRENT ISSUE DATE: ==

PROJECT INFORMATION:

03/04/14

SSUED FOR:

PERMITTING

BY: DATE: DESCRIPTION: REV			
ACI	03/04/14	CDs	0
BY	DATE	DESCRIPTION	REV

PLANS PREPARED BY: =



5711 Research Drive

ACI NUMBER

CONSTRUCTED BY:

nel YOUR NETWORK SYSTEMS

CAKN-014D

3030 Warrenville Rd, Suite 340 Lisle, IL 60532

SEAL OF APPROVAL:

SHEET TITLE:

TITLE SHEET AND PROJECT INFORMATION


SHEET NUMBER:

03/04/14

REVISION:

LP14-2014 OAKHILLS AT&T NORTH NETWORK OAKN-014D

(PROW) ARDMORE RD NEXT TO 801 COVINGTON RD, KENSINGTON, CA 94707

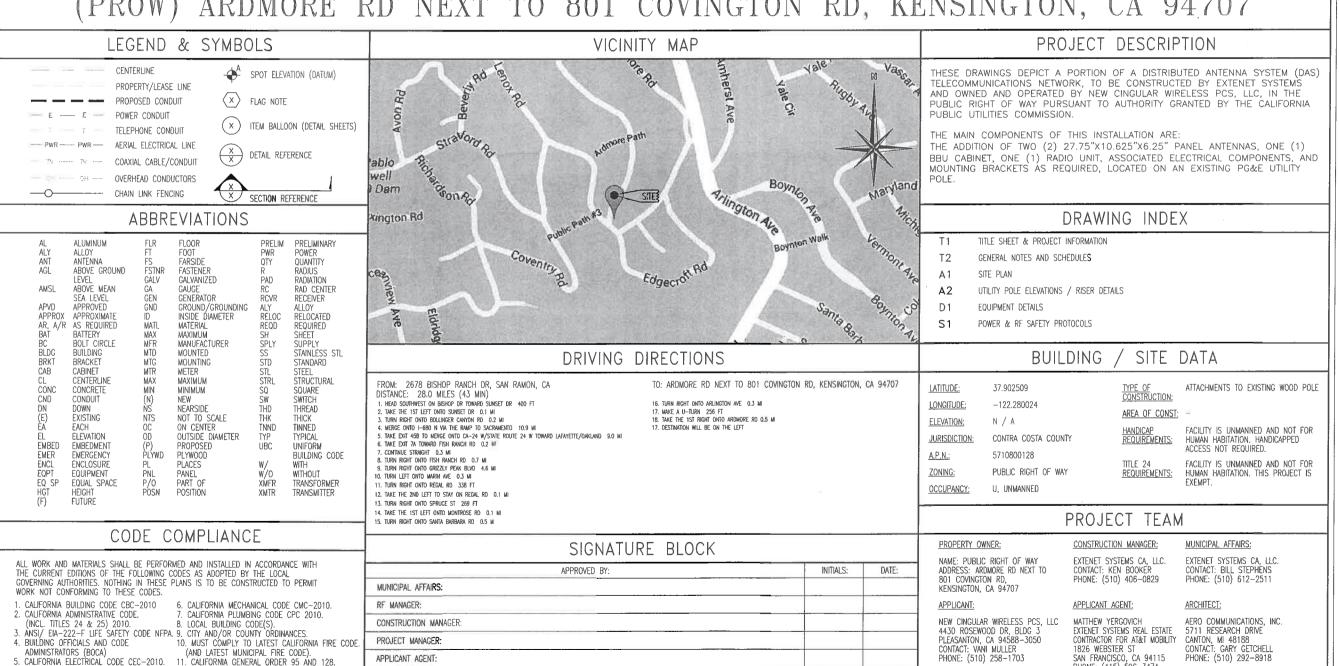

APPLICANT

GENERAL NOTES

- 1. THE CONTRACTOR SHALL BE RESPONSIBLE FOR SURVEY MONUMENTS AND/OR VERTICAL CONTROL BENCHMARKS WHICH ARE DISTURBED OR DESTROYED BY CONSTRUCTION. A LAND SURVEYOR MUST FIELD LOCATE, REFERENCE, AND/OR PRESERVE ALL HISTORICAL OR CONTROLLING MONUMENTS PRIOR TO ANY EARTHWORK. IF DESTROYED, SUCH MONUMENTS SHALL BE REPLACED WITH APPROPRIATE MONUMENTS BY A LAND SURVEYOR, A CORNER RECORD OR RECORD OF SURVEY, AS APPROPRIATE, SHALL BE FILED AS REQUIRED BY THE
- IMPORTANT NOTICE: SECTION 4215 OF THE GOVERNMENT CODE REQUIRES A DIG ALERT IDENTIFICATION NUMBER BE ISSUED REFORE A "PERMIT TO EXCAVATE" WILL BE VALID. FOR YOUR DIG ALERT LD. NUMBER. CALL UNDERGROUND SERVICE ALERT TOLL FREE 1-800-227-2600 TWO DAYS REFORE YOU DIG
- 3. CONTRACTOR SHALL BE RESPONSIBLE FOR THE POT HOLE AND LOCATING OF ALL EXISTING UTILITIES THAT CROSS THE PROPOSED TRENCH LINE AND MUST MAINTAIN A 1' MINIMUM VERTICAL CLEARANCE.
- AND CALCIUM PRIVIDENCE UN LANUSCAPE INDICATED ON THE APPROVE PLANS IS DAMAGED OR REMOVED DURING DEMOLITION OR CONSTRUCTION, IT SHALL BE REPAIRED AND/OR REPLACED IN KIND PER THE APPROVED PLANS.
- 5. CONTRACTOR SHALL REPLACE OR REPAIR ALL TRAFFIC SIGNAL LOOPS, CONDUIT, AND LANE STRIPING DAMAGED DURING CONSTRUCTION
- 6. THIS PROJECT WILL BE INSPECTED BY ENGINEERING AND FIELD ENGINEERING DIVISION.
- 7. MANHOLES OR COVERS SHALL BE LABELED EXTENET.
- CONTRACTOR SHALL IMPLEMENT AN EROSION CONTROL PROGRAM DURING THE PROJECT CONSTRUCTION ACTIVITIES, THE PROGRAM SHALL MEET THE APPLICABLE REQUIREMENTS OF THE STATE WATER RESOURCE CONTROL
- 9. THE CONTRACTOR SHALL HAVE EMERGENCY MATERIALS AND EQUIPMENT ON HAND FOR UNFORESEEN SITUATIONS, SUCH AS DAMAGE TO UNDERGROUND WATER, SEWER, AND STORM DRAIN FACILITIES WHEREBY FLOWS MAY GENERATE EROSION AND SEDIMENT POLLUTION.

CALTRANS NOTES

ANY REMOVED OR DAMAGED STRIPING AND MARKINGS SHALL BE REPLACED IN KIND AS PER CALTRANS STANDARDS AND AT PERMITTEE'S EXPENSE.



811 / 1-800-227-2600 www.usanorth.org

- 1. INDEMNIFICATION CLAUSE: THE CONTRACTOR AGREES AND SHALL:
 ASSUME SOLE AND COMPLETE RESPONSIBILITY OF THE JOB SITE CONDITIONS DURING THE COURSE OF
 CONSTRUCTION OF THIS PROJECT, INCLUDING THE SAFETY OF ALL PERSONS AND PROPERTIES. THAT THESE
 REQUIREMENTS SHALL APPLY CONTRADUSLY AND NOT BE LIMITED TO NORMAL WORKING HOURS AND CONDITIONS.
 THE CONTRACTOR FURTHER AGREES TO DEFEND INDEMNITY AND HOLD EXTERM, REPRESENTATIVES, AND
 ENGINEERS HARMLESS FROM ANY AND ALL LIABILITY, REAL OR ALLEGED IN CONNECTION WITH THE PERFORMANCE OF THE WORK ON THIS PROJECT.
- 2 PRIOR TO THE RECINNING OF ANY CONSTRUCTION AND THROUGHOUT THE COURSE OF CONSTRUCTION WORK THE CONTRACTOR SHALL FULLY COMPLY WITH "CAUFORNIA OCCUPATIONAL SAFETY AND HEALTH" ACT OF 1973 INCLUDING ALL REVISIONS AND AMENDMENTS THERETO.
- 3. ALL WORK SHALL CONFORM TO THE LATEST EDITIONS OF GO95 128 AND THE STANDARD "SPECIFICATIONS FOR PUBLIC WORKS CONSTRUCTION" AS ADOPTED BY THE CITY, COUNTY OR STATE AS MODIFIED BY STANDARD PLANS
- THE EXISTENCE AND LOCATION OF UTILITIES AND OTHER ACENCY'S FACILITIES AS SHOWN HERON ARE 4. THE EXISTENCE AND LOCATION OF UILDITES AND OTHER AGENCY 5 PAILIDIES AS SHOWN HEREON ARE
 OFFINED BY A SEARCH OF AVAILABLE RECORDS, OTHER FACILITIES MAY EXIST. THE CONTRACTOR SHALL VERIFY
 PRIOR TO THE START OF CONSTRUCTION AND SHALL USE EXTREME CARE AND PROTECTIVE MEASURES TO
 PREVENT DAMAGE TO THESE FACILITIES. THE CONTRACTOR IS RESPONSIBLE FOR THE PROTECTION OF ALL UTILITY OR AGENCY FACILITIES WITHIN THE LIMITS OF WORK, WHETHER THEY ARE SHOWN ON THIS PLAN OR NOT.
- 5. THE CONTRACTOR SHALL NOTICY THE CITY COLINTY OR STATE ENGINEER INSPECTION DEPARTMENT AT LEAST TWO DAYS REFORE START OF ANY WORK REQUIRING THEIR INVOLVEMENT
- THE CITY, COUNTY OR STATE SHALL SPECIFY THE EXPIRATION PERIOD OF THE PERMIT FOR THIS
- 7. THE MINIMUM COVER FOR ALL CONDUITS PLACED UNDERGROUND SHALL BE 30 INCHES TO THE FINISHED
- 8. THE CONTRACTOR SHALL TUNNEL ALL CURB AND GUTTERS AND BORE ALL CONCRETE DRIVEWAYS AND WALKWAYS AT THE DIRECTION OF THE CITY, COUNTY OR STATE ENGINEER.
- . ALL A.C AND/OR CONCRETE PAVEMENT SHALL BE REPLACED AT THE DIRECTION OF THE CITY, COUNTY OR
- 10. ALL SHRUBS, PLANTS OR TREES THAT HAVE BEEN DAMAGED OR DISTURBED DURING THE COURSE OF THE WORK, SHALL BE REPLANTED AND/OR REPLACED SO AS TO RESTORE THE WORK SITE TO ITS ORIGINAL CONDITION
- 11. THE CONTRACTOR WILL BE RESPONSIBLE FOR THE PROCESSING OF ALL APPLICANT PERMIT FORMS ALONG WITH THE REGUMEN LIABILITY INSURANCE FORMS CLEARLY DEMONSTRATING THAT EXTENT THE CITY COUNTY OR STATE IS ALSO INSURED WITH THE REQUIRED LIABILITY INSURANCE IN THE AMOUNT OF \$1,000,000.00 FOR THIS
- 2. VAULTS, PEDESTALS, CONDUITS AND OTHER TYPES OF SUBSTRUCTURE ARE EITHER SPECIFIED ON THIS PLAN OR WILL BE SPECIFIED BY THE CONSTRUCTION ENGINEER, ANY AND ALL DEVIATIONS FROM THE SPECIFIED TYPES OF MATERIAL MUST BE APPROVED BY THE SYSTEM ENGINEER, IN WRITING BEFORE INSTALLATION THEREOF.
- THE CONTRACTOR SHALL VERIFY THE LOCATION OF ALL EXISTING UTILITIES IN INCLUDING SEWER LATERALS & WATER SERVICES TO INDIVIDUAL LOTS BOTH VERTICAL AND HORIZONTAL PRIOR TO COMMENCING IMPROVEMENT
- 14. CONTRACTOR SHALL MAKE EXPLORATION EXCAVATIONS AND LOCATE EXISTING FACILITIES SUFFICIENTLY AHEAD OF CONSTRUCTION TO PERMIT REVISIONS TO PLANS IF REVISION IS NECESSARY BECAUSE OF LOCATION OF
- 15. THE LOCATIONS OF ALL EXISTING UTILITIES SHOWN ON THESE PLANS ARE FROM EXISTING RECORDS AND CORROBORATED, WHERE POSSIBLE, WITH FIELD TEX. THE CONTRACTOR IS RESPONSIBLE FOR CONTRINUNG THE LOCATIONS SHOWN, BOTH HORZONTAL SUBSTANTIALLY FROM THE PLANS. THE ENGINEER SHOULD BE NOTIFIED TO MAKE ANY CONSTRUCTION CHANGES

EROSION AND SEDIMENT CONTROL NOTES

TEMPORARY EROSION/SEDIMENT CONTROL PRIOR TO COMPLETION OF FINAL IMPROVEMENTS, SHALL BE PERFORMED BY THE CONTRACTOR OR QUALIFIED PERSON AS INDICATED BELOW:

- ALL REQUIREMENTS OF THE CITY, COUNTY AND STATE "STORM WATER STANDARDS" MUST BE INCORPORATED INTO THE DESIGN AND CONSTRUCTION OF THE PROPOSED GRADING/IMPROVMENTS CONSISTENT WITH THE APPROVED STORM WATER POLLUTION PREVENTION PLAN (SWPPP), WATER QUALITY TECHNICAL REPORT (WQTR), AND/OR WATER POLLUTION CONTROL PLAN (WPCP).
- 2. FOR STORM DRAIN INLETS, PROVIDE A GRAVEL BAG SILT BASIN IMMEDIATELY UPSTREAM OF INLET AS
- 3. FOR INLETS LOCATED AT SUMPS ADJACENT TO TOP OF SLOPES. THE CONTRACTOR SHALL ENSURE THAT WATER DRAINING TO THE SUMP IS DIRECTED INTO THE INLET AND THAT A MINIMUM OF 1.00' FREEBOARD EXISTS AND IS MAINTAINED ARGVE THE TOP OF THE INLET IF FREEBOARD IS NOT PROVIDED BY GRADING SHOWN ON THESE PLANS THE CONTRACTOR SHALL PROVIDE IT VIA TEMPORARY MEASURES, I.E. GRAVEL BAGS OR DIKES
- . THE CONTRACTOR OR QUALIFIED PERSON SHALL BE RESPONSIBLE FOR CLEANUP OF SILT AND MUD ON ADJACENT STREET(S) AND STORM DRAIN SYSTEM DUE TO CONSTRUCTION ACTIVITY.
- THE CONTRACTOR OR QUALIFIED PERSON SHALL CHECK AND MAINTAIN ALL LINED AND UNLINED DITCHES
- 6. THE CONTRACTOR SHALL REMOVE SILT AND DEBRIS AFTER EACH MAJOR RAINFALL.
- 7. FOLIPMENT AND WORKERS FOR EMERGENCY WORK SHALL BE MADE AVAILABLE AT ALL TIMES DURING THE AINY SEASON ALL NECESSARY MATERIALS SHALL BE STOCKPILED ON SITE AT CONVENIENT LOCATIONS TO FACILITATE RAPID CONSTRUCTION OF TEMPORARY DEVICES WHEN RAIN IS IMMINENT.
- SATISFACTION OF THE CITY ENGINEER OF RESIDENT ENGINEER AFTER EACH RUN-OFF PRODUCING RAINFALL.
-). THE CONTRACTOR SHALL INSTALL ADDITIONAL EROSION/SEDIMENT CONTROL MEASURES AS MAY BE REQUIRED BY THE RESIDENT ENGINEER DUE TO UNCOMPLETED GRADING OPERATIONS OR UNFORESEEN CIRCUMSTANCES, WHICH MAY ARISE.
- 10. THE CONTRACTOR SHALL BE RESPONSIBLE AND SHALL TAKE NECESSARY PRECAUTIONS TO PREVENT PUBLIC TRESPASS ONTO AREAS WHERE IMPOUNDED WATERS CREATE A HAZARDOUS CONDITION
- 11. ALL EROSION/SEDIMENT CONTROL MEASURES PROVIDED PER THE APPROVED GRADING PLAN SHALL BE INCORPORATED HERON, ALL EROSION/SEDIMENT CONTROL FOR INTERIM CONDITIONS SHALL BE DONE TO THE SATISFACTION OF THE RESIDENT ENGINEER.
- GRADED AREAS AROUND THE PROJECT PERIMETER MUST DRAIN AWAY FROM THE FACE OF THE SLOPE AT
- 13. ALL REMOVABLE PROTECTIVE DEVICES SHOWN SHALL BE IN PLACE AT THE END OF EACH WORKING DAY WHEN RAIN IS IMMINENT.
- 14. THE CONTRACTOR SHALL ONLY GRADE, INCLUDING CLEARING AND GRUBBING FOR THE AREAS FOR WHICH THE CONTRACTOR OR QUALIFIED PERSON CAN PROVIDE EROSION/SEDIMENT CONTROL MEASURES
- 15. THE CONTRACTOR SHALL ARRANGE FOR WEEKLY MEETINGS DURING OCTOBER 1ST TO APRIL 30TH FOR PROJECT TEAM (GENERAL CONTRACTOR, QUALIFIED PERSON, EROSION CONTROL SUBCONTRACTOR IF AN, ENGINEER OF WORK, OWNER/DEVELOPER AND THE RESIDENT ENGINEER) TO EVALUATE THE ADEQUACY OF THE FROSION/SEDIMENT CONTROL MEASURE AND OTHER RELATED CONSTRUCTION ACTIVITIES.

SCALE NTS

GENERAL NOTES

ROW GROUND CONSTRUCTION NOTES:

- 120/240 POWER REQUIRED FOR 3-WIRE SERVICE.
- 120/240 POWER REQUIRED FOR 3—WIRE SERVICE.

 1. NO BOLT THREADS TO PROTRUDE MORE THAN 1-1/2".

 1. NO BOLT THREADS TO PROTRUDE MORE THAN 1-1/2".

 2. CALL CONSTRUCTION SHALL BE IN ACCORDANCE WITH MUNICIPAL, COUNTY, STATE, FEDERAL, CO95 AND GO128 STANDARDS AND REQULATIONS.

 3. CALL USA 48 HOURS PRIOR TO EXCAVATING AT (B00) 227-2600.

 4. ALL LANDSCAPING TO BE RESTORED TO ORIGINAL CONDITION OR BETTER.

 4. CABLE NOT TO IMPEDE 15" CLEAR SPACE OFF POLE FACE (12-00).

 5. 90" SHORT SWEEPS UNDER ANTENNA ARM. ALL CABLES MU

- 7. METERING CABINET REQUIRES 3' CLEARANCE AT DOOR OPENING.
 8. CAULK CABINET BASE AT PAD.

STANDARD GROUNDING NOTES:

- GROUND TESTED AT 5 OHMS OR LESS.
- 5/8"x8' ROD, CAD WELD BELOW GRADE
- #6 GROUND AND BOND WIRE.
- WOOD MOLDING, STAPLED EVERY 3' AND AT EACH END GROUNDS 3' FROM POLE.
- 6. PLACE 3 #10GA WIRES FROM BREAKER TO METER BOX.

STANDARD CONDUIT NOTES:

- 1. FOR UNDERCROUND USE SCHEDULE 40.
 2. FOR RISERS USE SCHEDULE 80.
 3. PLACE 2" GALVANIZED STEEL CONDUIT FOR ANY CONDUIT UNDER 3", STUB UP 10' THEN CONVERT TO SCHEDULE 80.
 4. CONVERT 4" CARRIER CONDUIT TO 3" AT BASE OF POLE.
 5. GC TO STUB UP POLE 10' w/3" POWER CONDUIT, POWER CO. TO CONVERT FROM 3" SCH. 80 TO 2" SCH. 80 FROM TOP OF STUB UP.
 6. ALL CONDUIT WILL BE MAN DRILLED AND EQUIPPED WITH 3/8" PULL, ROPE.

STANDARD TRENCHING NOTES:

- 1 MAINTAIN 40" MINIMUM COVER FOR FLECTRICAL CONDUIT.
- MAINTAIN 30" MINIMUM COVER FOR COMMUNICATIONS CONDUIT.
 SAND SHADING MINIMUM 1" UNDER CONDUITS, AND 6" COVERING ON TOP
- REQUIRED.

 4. ALL ELECTRICAL SERVICE CONDUITS FROM POWER COMPANY, WHETHER FROM POLES, TRANSFORMERS, OR OTHER LOCATIONS; WILL BE SLURRY BACKFILLED.

 5. IN STREET SLURRY TO GRADE AND MILL DOWN 1-1/2" FOR AC CAP.
- 5. IN DIRT SLURRY 18" FROM GRADE, AND FILL WITH 95% COMPACTION NATIVE SOIL FOR BALANCE.

 7. PLACE WARNING TAPE IN TRENCH 12" ABOVE ALL CONDUITS AND #18 WARNING TAPE ABOVE GROUND RING.

ROW UTILITY POLE CONSTRUCTION NOTES:

- NO BOLT THREADS TO PROTRUDE MORE THAN 1-1/2"
- 3. ALL CLIMB STEPS NEXT TO CONDUIT SHALL HAVE EXTENDED STEPS.
- 4. CABLE NOT TO IMPEDE 15" CLEAR SPACE OFF POLE FACE
- (12:00).
 5. 90° SHORT SWEEPS UNDER ANTENNA ARM. ALL CABLES MUST
- 5. 90 SHORT SWEEP'S UNDER AMIENNA ARM. ALL CABLES MISSONLY TRANSTION ON THE INSIDE OR BOTTOM OF ARMS (MO CABLE ON TOP OF ARMS).

 6. USE CABLE CLAMPS TO SECURE CABLE TO ARMS; PLACE 2" CARRIER CABLE ID TAGS ON BOTH SIDES OF ARMS.

 7. USE 90' CONNECTOR AT CABLE CONNECTION TO ANTENNAS.

 8. PLACE GPS ON ARM WITH SOUTHERN SKY EXPOSURE AT
- MINIMUM 6' FROM TRANSMIT ANTENNA, WHICH IS 24" AWAY FROM CENTER OF POLE.
- 9. USE 1/2" CABLE ON ANTENNAS UNLESS OTHERWISE SPECIFIED. 10. FILL VOID AROUND CABLES AT CONDUIT OPENING WITH FOAM SEALANT TO PREVENT WATER INTRUSION.

WIND LOADING INFORMATION		
ANTENNA/WOOD ARM AREA TOTAL	39.02 SQ. FT.	
TOP GRADE	50'-5"	
BOTTOM GRADE	47'-6"	
BREAKER AREA TOTAL	14.62 SQ. FT.	
TOP GRADE	8'-11"	
BOTTOM GRADE	8'-0"	
BATTERY BACK-UP AREA TOTAL	40.5 SQ. FT.	
TOP GRADE	18'-9"	
BOTTOM GRADE	16'-6"	
PRISM DECK AREA TOTAL	50.77 SQ. FT.	
TOP GRADE	15'-9"	
BOTTOM GRADE	11'-7"	
PRISM DECK (FUT.) AREA TOTAL	_	
TOP GRADE	-	
BOTTOM GRADE	-	
COAX RISER SIZE	3″U	
COAX RISER TOP GRADE	47'0"	
COAX RISER BTM GRADE	11'-7"	
PWR RISER SIZE	1 °ø	
PWR RISER TOP GRADE	32'-9"	
PWR RISER BTM GRADE	8'-0"	

ANTENNA SECTOR	AZIMUTH	ANTENNA MAKE / MODEL	COAXIAL CABLE LENGTH	CABLES PER SECTOR	CABLE SIZE
SECTOR ALPHA	TBD*	KATHREIN 840~10525	35'/3'	4/6	1/2"
SECTOR BETA	LBD.	KATHREIN 840–10525	-	-	-
SECTOR GAMMA					



4430 ROSEWOOD DR BLDG 3

PROJECT INFORMATION:

OAKHILLS AT&T NORTH NETWORK NODE 014D ARDMORE RD NEXT TO 801 COVINGTON RD, KENSINGTON, CA 94707

CURRENT ISSUE DATE:

03/04/14

ISSUED FOR: =

PERMITTING

BY: = DATE: = DESCRIPTION: = REV: ACI 03/04/14 CDs DATE DESCRIPTION

=PLANS PREPARED BY:



ACL NUMBER: OAKN-014D CONSTRUCTED BY:

enet your NETWOR YOUR NETWORK

3030 Warrenville Rd. Suite 340 Lisle, IL 60532 www.extenet.com

=SEAL OF APPROVAL: ==

GENERAL NOTES AND SCHEDULES

SHEET NUMBER: === REVISION:


ROW CONSTRUCTION GENERAL NOTES


SCALE 3 LOADING AND ANTENNA CABLE SCHEDULES

SCALE NTS


SHEET TITLE:

03/04/14

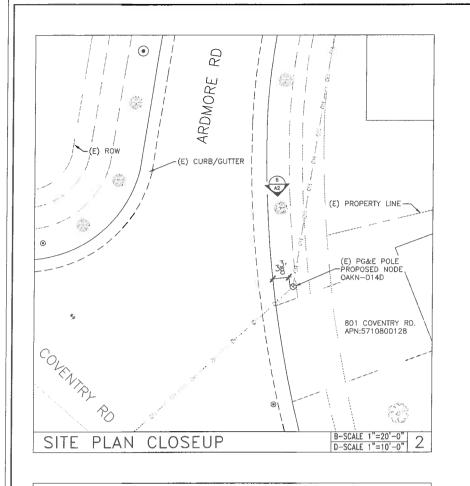

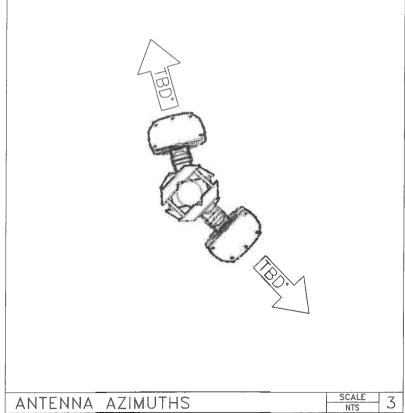

SITE PLAN

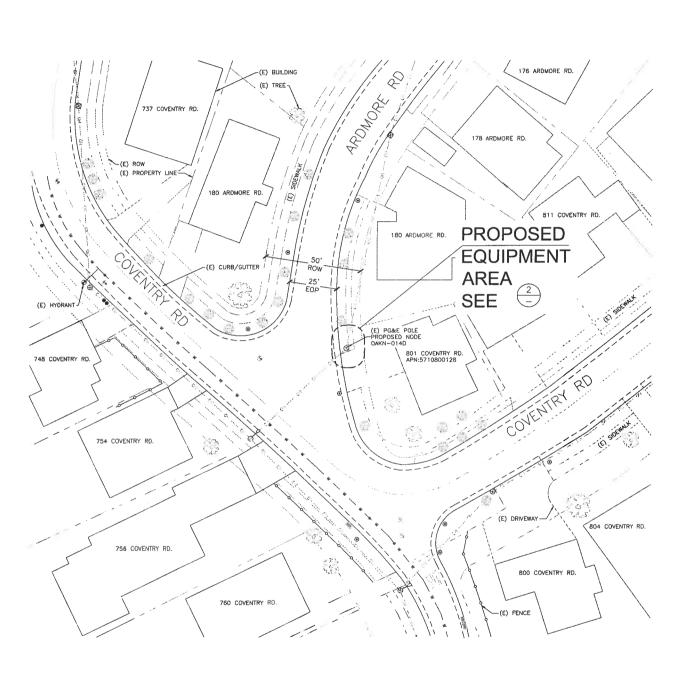



NEW CINGULAR WIRELESS PCS, LLC 4430 ROSEWOOD DR, BLDG 3 PLEASANTON, CA 94588-3050

PROJECT INFORMATION:

OAKHILLS AT&T NORTH NETWORK NODE 014D

ARDMORE RD NEXT TO 801 COVINGTON RD, KENSINGTON, CA 94707

CURRENT ISSUE DATE:

03/04/14

SSUED FOR:

PERMITTING

BY: = DATE: = DESCRIPTION: ==== REV:

ACI	03/04/14	CDs	0
BY	DATE	DESCRIPTION	REV

PLANS PREPARED BY: =



ACI NUMBER:

OAKN-014D

CONSTRUCTED BY:



3030 Warrenville Rd, Suite 340 Lisle, IL 60532 www.extenet.com


SEAL OF APPROVAL: =


SHEET TITLE: =

SITE PLAN

SHEET NUMBER: =REVISION: =

03/04/14

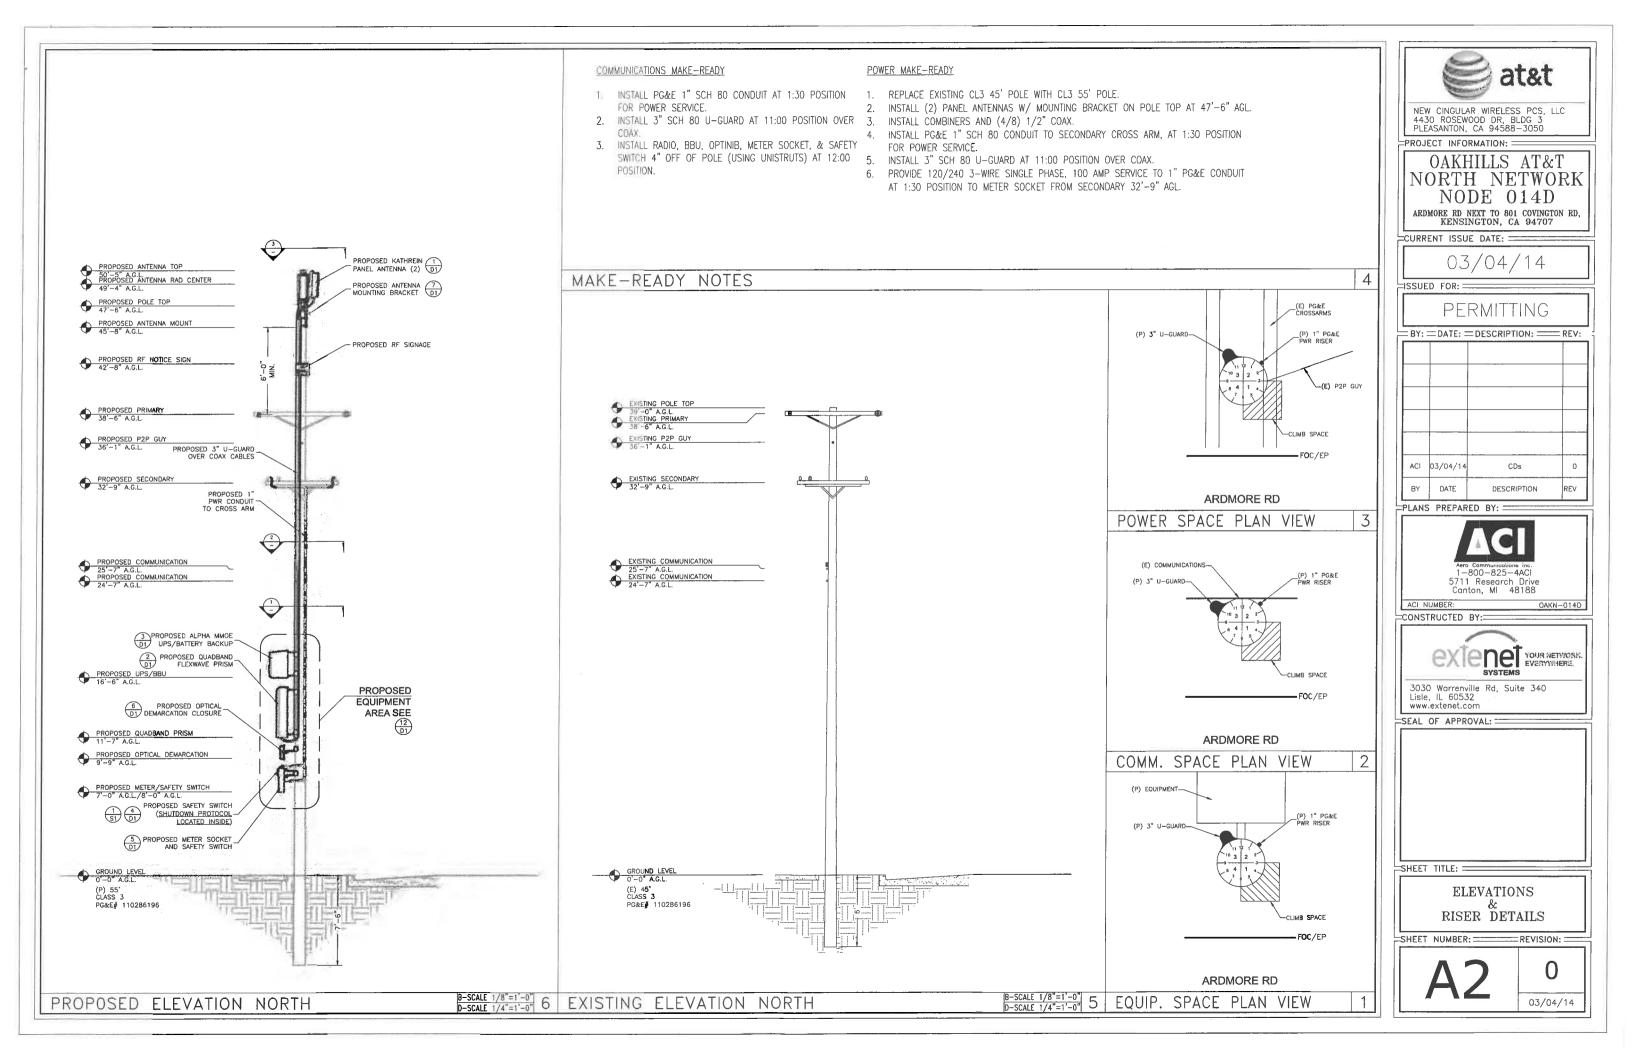

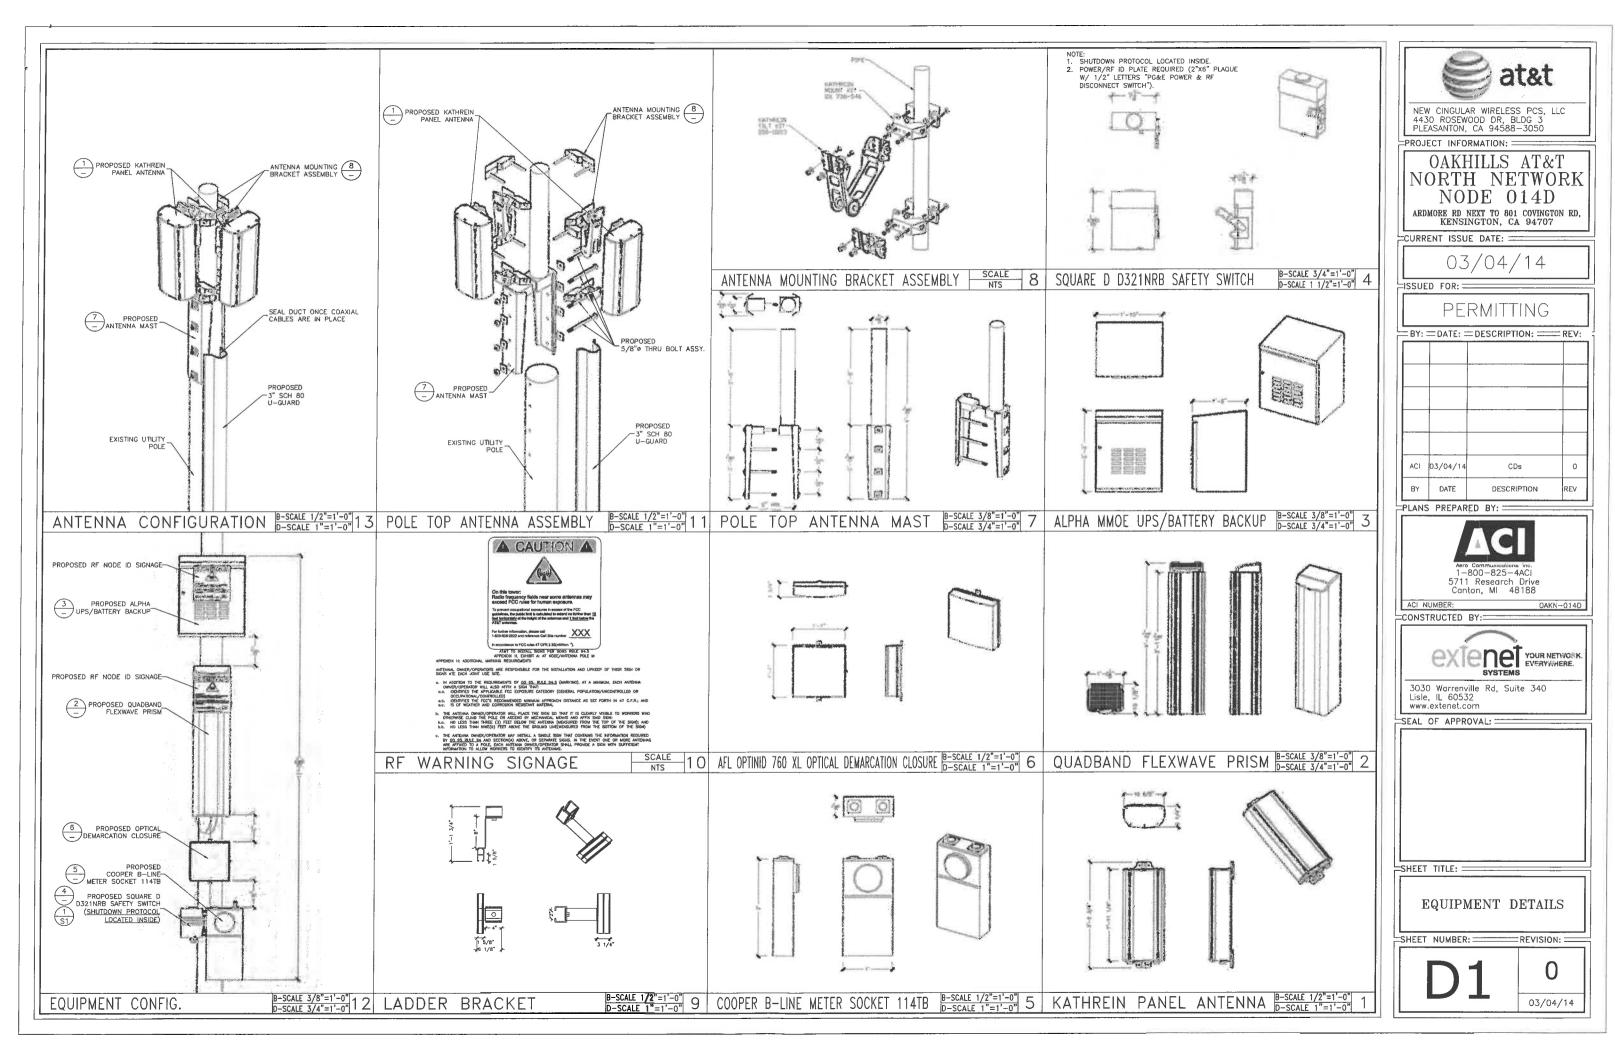

SHUTDOWN PROTOCOL 7"X9" LAMINATED CARD CARDSTOCK



AT&T oDAS Shutdown Procedure

PROCEDURE TO DE-ENERGIZE RADIO FREQUENCY (RF) SIGNAL **EMERGENCY and NON-EMERGENCY WORK REQUIRING RF SIGNAL** SHUTDOWN

- (A) PG&E personnel SHALL contact AT&T Mobility Switch Center to notify them of an emergency shutdown 800-638-2822, Dial option 9 for cell site "Related" emergency's then option 1. Provide the following information when calling or leave a voicemail:
- (1) Identify yourself and give callback phone number.
- (2) Site number and if applicable site name (located on the shutdown box)
- (3) Site address and location
- (4) Nature of emergency and site condition
- (B) Pull Disconnect Handle down to the Open or "OFF" Position. The RF signal will shut down within a few seconds. A visual inspection of the interior blade will confirm that both incoming AC lead and Battery Backup are disconnected.
- (C) Notify AT&T (New Cingular) Switch Center when the emergency work is completed.

See reverse side to view photo of the "on" and "off" position.




Switch in the Closed Position ("ON")





Switch in the Open Position ("Off")



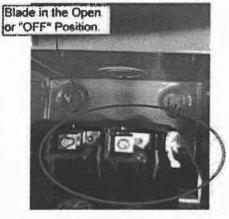

BACK



4430 ROSEWOOD DR, BLDG 3 PLEASANTON, CA 94588-3050

PROJECT INFORMATION:

OAKHILLS AT&T NORTH NETWORK NODE 014D

ARDMORE RD NEXT TO 801 COVINGTON RD, KENSINGTON, CA 94707

CURRENT ISSUE DATE:

ISSUED FOR:

ĺ	BY:DATE:DESCRIPTION: REV:			
	ACI	03/04/14	CDs	0
	BY	DATE	DESCRIPTION	REV

PLANS PREPARED BY:



ACI NUMBER:

CONSTRUCTED BY



3030 Warrenville Rd, Suite 340 Lisle, IL 60532 www.extenet.com

SEAL OF APPROVAL: =

=SHEET TITLE: =

POWER & RF SAFETY PROTOCOLS

SHEET NUMBER: =

03/04/14

=REVISION:

FRONT